<u>Staff Report and Comments</u> Grinnell/General Fire Extinguisher Company 1435 West Morehead St. Charlotte, NC Application for COA HLC390

Exhibits presented to and considered by the Commission:

Exhibit A - Project Description

1. Interior renovation and exterior modifications

Exhibit B – Map

Exhibit C – Project Plans

Based upon the information presented in the application, staff offers the following suggested findings of fact:

The HLC has acknowledged the need to alter or add to a historic property to meet continuing or new uses while retaining the property's historic character.

- 1. The project is a reconstruction of the front entrance and interior modifications.
- The proposed project meets the HLC Standard 1. A property shall be used for its historic purpose or be placed in a new use that requires minimal change to the defining characteristics of the building and its site and environment.
- 3. The proposed project meets the HLC Standard 2. Distinctive materials, features, finishes and construction techniques or examples of craftsmanship that characterize a property will be preserved.
- 4. The proposed project meets the HLC Standard 3. Each property shall be recognized as a physical record of its time, place, and use.
- The proposed project meets the HLC Standard 5. Distinctive features, finishes, and construction techniques or examples of craftsmanship that characterize a historic property shall be preserved.
- 6. The proposed project meets the HLC Standard 9. New additions, alterations, or related new construction shall not destroy historic materials that characterize the property.
- The proposed project meets the HLC Standard 10. Alterations, new additions, and adjacent or related new construction shall be undertaken in such a manner that if removed in the future, the essential form and integrity of the historic property and its environment would be unimpaired.

Staff suggests that the Commission approve the application as presented.

THE HLC STANDARDS


Rehabilitation is defined as the act or process of making possible a compatible use for a property through repair, alterations, and additions while preserving those portions or features which convey its historical, cultural, or architectural values.

- 1. A property shall be used for its historic purpose or be placed in a new use that requires minimal change to the defining characteristics of the building and its site and environment.
- 2. The historic character of a property shall be retained and preserved. The removal of historic materials or alteration of features and spaces that characterize a property shall be avoided.
- 3. Each property shall be recognized as a physical record of its time, place, and use. Changes that create a false sense of historical development, such as adding conjectural features or architectural elements from other buildings, shall not be undertaken.
- 4. Most properties change over time; those changes that have acquired historic significance in their own right shall be retained and preserved.
- 5. Distinctive features, finishes, and construction techniques or examples of craftsmanship that characterize a historic property shall be preserved.
- 6. Deteriorated historic features shall be repaired rather than replaced. Where the severity of deterioration requires replacement of a distinctive feature, the new feature shall match the old in design, color, texture, and other visual qualities and, where possible, materials. Replacement of missing features shall be substantiated by documentary, physical, or pictorial evidence.
- 7. Chemical or physical treatments, such as sandblasting, that cause damage to historic materials shall not be used. The surface cleaning of structures, if appropriate, shall be undertaken using the gentlest means possible.
- 8. Significant archeological resources affected by a project shall be protected and preserved. If such resources must be disturbed, mitigation measures shall be undertaken.
- 9. New additions, alterations, or related new construction shall not destroy historic materials that characterize the property. The new work shall be differentiated from the old and shall be compatible with the massing, size, scale, and architectural features to protect the historic integrity of the property and its environment.
- 10. Alterations, new additions, and adjacent or related new construction shall be undertaken in such a manner that if removed in the future, the essential form and integrity of the historic property and its environment would be unimpaired.

Polaris 3G Map – Mecklenburg County, North Carolina

Exhibit **B**

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ASANA PARTNERS OWNER
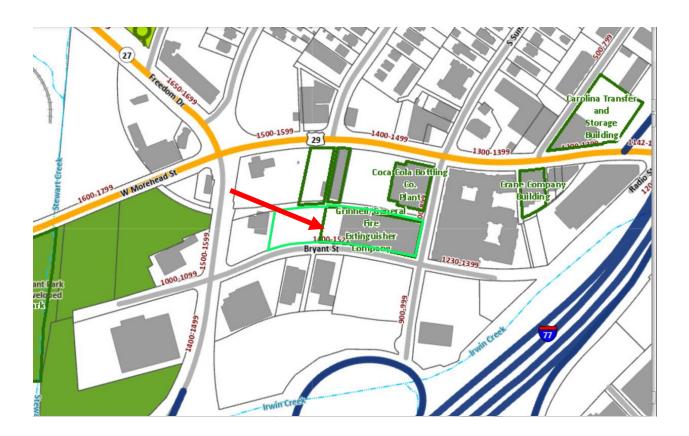
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Asana Partners 1616 Camden Road, Suite 210 Charlotte, NC 28203 vc 704 | 423 | 1660 contact: Welch Liles



ARCHITECTURAL

BeachamBunce+Manley ARCHITECTURE pllc 1900 West Morehead Street, Suite 200 Charlotte, North Carolina 28208 vc 704|334|1716 contact: Heath Wickline

GRINNELL WATER WORKS - INTERIOR RENOVATION



STRUCTURAL

Noble Structural Group 17505 W. Catawba Ave, Ste 220 Cornelius, NC 28031 vc 980 | 689 | 2392 contact: John Noble



MECHANICAL, PLUMBING, ELECTRICAL Barrett, Woodyard & Associates. Inc. 420 Minuet Lane Charlotte, NC 28217 vc 704 | 357 | 9333 contact: Harrison Ward



FOR CONSTRUCTION

SHEET NAME		
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COVER SHEET		
APPENDIX B INTERIOR		
ACCESSIBILITY STANDARDS - GENERAL		
TY		
OVERALL LIFE SAFETY PLAN		
ÎON		
OVERALL INTERIOR DEMO FLOOR PLAN		
ENLARGED DEMOLITION PLAN - ENTRYWAY		
ID ENLARGED DEMO PLAN - LOBBY + RESTROOMS		
ID ENLARGED DEMO PLAN - BUILDING CORRIDORS		
ID ENLARGED DEMO PLAN - UNIT 100		
ID ENLARGED DEMO PLAN - UNIT 120		
OVERALL REFLECTED DEMO CEILING PLAN		
ENLARGED DEMO RCP - LOBBY AND RESTROOMS		
ENLARGED DEMO RCP - BUILDING CORRIDORS		
ENLARGED DEMO RCP - UNIT 100		
ENLARGED DEMO RCP - UNIT 120		
CTURAL		
OVERALL INTERIOR FLOOR PLAN		
ENLARGED PLAN - ENTRYWAY		
ID ENLARGED FLOOR PLAN - LOBBY + RESTROOMS		
ID ENLARGED FINISH PLAN - LOBBY + RESTROOMS		
ID ENLARGED FURN. + P-COMM. PLAN - LOBBY + RESTROOMS		
ID ELEVATIONS - LOBBY + RESTROOMS		
ID ELEVATIONS - LOBBY + RESTROOMS		
ID MILLWORK PLANS, DETAILS + SECTIONS - LOBBY + RESTROOM		
ID RENDERINGS - LOBBY + RESTROOMS		
ID ENLARGED FLOOR PLAN - BUILDING CORRIDOR		
ID ENLARGED FINISH PLAN - BUILDING CORRIDORS		
ID ENLARGED FURN. + P-COMM. PLAN - BUILDING CORRIDORS		
ID ELEVATIONS - BUILDING CORRIDORS		
ID MILLWORK PLANS, DETAILS + SECTIONS - CORRIDOR BOOTHS		
ID RENDERINGS - BUILDING CORRIDOR		
ID ENLARGED FLOOR PLAN - UNIT 100		
ID ENLARGED FINISH PLAN - UNIT 100		
ID ENLARGED FURN. + P-COMM. PLAN - UNIT 100		
ID ELEVATIONS - UNIT 100		
ID ENLARGED FLOOR PLAN - UNIT 120		
ID ENLARGED FINISH PLAN - UNIT 120		
ID ENLARGED FURN. + P-COMM. PLAN - UNIT 120		
ID MILLWORK PLANS, DETAILS + SECTIONS - UNIT 120		
ID RENDERINGS - UNIT 120		
OVERALL REFLECTED CEILING PLAN		
ENLARGED REFLECTED CEILING PLAN - LOBBY AND RESTROOMS		
ENLARGED REFLECTED CEILING PLAN - BUILDING CORRIDORS		
ENLARGED REFLECTED CEILING PLAN - UNIT 100		
ENLARGED REFLECTED CEILING PLAN - UNIT 120		
PARTITION TYPES - INTERIOR		
CONCRETE STAIRS		

SHEET NUMBER	SHEET NAME
A9.30	ID FLOOR TRANSITIONS, CASEMENT, BASE + TRIM DETAILS
A9.40	ID RCP SECTIONS + DETAILS
A10.00	LOBBY + CORRIDORS - FINISH SCHEDULE
A10.10	SUITES - FINISH SCHEDULES
A10.20	EQUIPMENT, PLUMBING + LIGHTING SCHEDULES
D3 STRUCTU	
50.00	LEGENDS & SYMBOLS
S1.11	FOUNDATION PLAN
S4.01	SECTIONS
\$5.01	TYPICAL DETAILS
04 MECHAI	
M0.01	
	LEGENDS, NOTES & SCHEDULES
M0.02	DETAILS - MECHANICAL
M0.03	SPECIFICATIONS - MECHANICAL
M0.04	SPECIFICATIONS - MECHANICAL
M1.00	
M1.01	ENLARGED FLOOR PLAN - UNIT 100 - MECHANICAL
M1.02	ENLARGED FLOOR PLAN - UNIT 120 - MECHANICAL
05 PLUMBIN	
P0.01	LEGEND, NOTES, DETAILS & SCHEDULES
P0.02	SPECIFICATIONS - PLUMBING
P0.03	SPECIFICATIONS - PLUMBING
P1.00	OVERALL FLOOR PLAN - PLUMBINGS
P1.01	ENLARGED FLOOR PLAN - LOBBY + RESTROOMS - PLUMBING
P1.02	ENLARGED FLOOR PLAN - UNIT 100 - PLUMBING
P1.03	ENLARGED FLOOR PLAN - UNIT 120 - PLUMBING
	-
E0.01	LEGEND, DETAILS, AND NOTES
E0.02	SPECIFICATIONS - ELECTRICAL
E0.03	SPECIFICATIONS - ELECTRICAL
E0.04	RISER DIAGRAM AND PANEL SCHEDULES
E0.05	LIGHTING FIXTURE SCHEDULE
E1.00	OVERALL FLOOR PLAN - ELECTRICAL
E1.01	ENLARGED FLOOR PLAN - LOBBY + RESTROOMS - ELECTRICAL
E1.02	ENLARGED FLOOR PLAN - BUILDING CORRIDOR - ELECTRICAL
E1.03	ENLARGED FLOOR PLAN - UNIT 100 - ELECTRICAL
E1.04	ENLARGED FLOOR PLAN - UNIT 120 - ELECTRICAL
E1.05	ENLARGED FLOOR PLAN - ENTRYWAY - ELECTRICAL
E2.00	OVERALL FLOOR PLAN - LIGHTING
E2.01	ENLARGED FLOOR PLAN - LOBBY + RESTROOMS - LIGHTING
E2.02	ENLARGED FLOOR PLAN - BUILDING CORRIDOR - LIGHTING
E2.03	ENLARGED FLOOR PLAN - UNIT 100 - LIGHTING
E2.04	ENLARGED FLOOR PLAN - UNIT 120 - LIGHTING
E2.05	ENLARGED FLOOR PLAN - ENTRYWAY - LIGHTING
E3.00	OVERALL FLOOR PLAN - FIRE ALARM
E3.01	ENLARGED FLOOR PLAN - LOBBY + RESTROOMS - FIRE ALARM
E3.02	ENLARGED FLOOR PLAN - BUILDING CORRIDOR - FIRE ALARM
E3.03	ENLARGED FLOOR PLAN - UNIT 100 - FIRE ALARM
E3.04	ENLARGED FLOOR PLAN - UNIT 120 - FIRE ALARM
E3.05	ENLARGED FLOOR PLAN - ENTRYWAY - FIRE ALARM
07 FIRE PRC	









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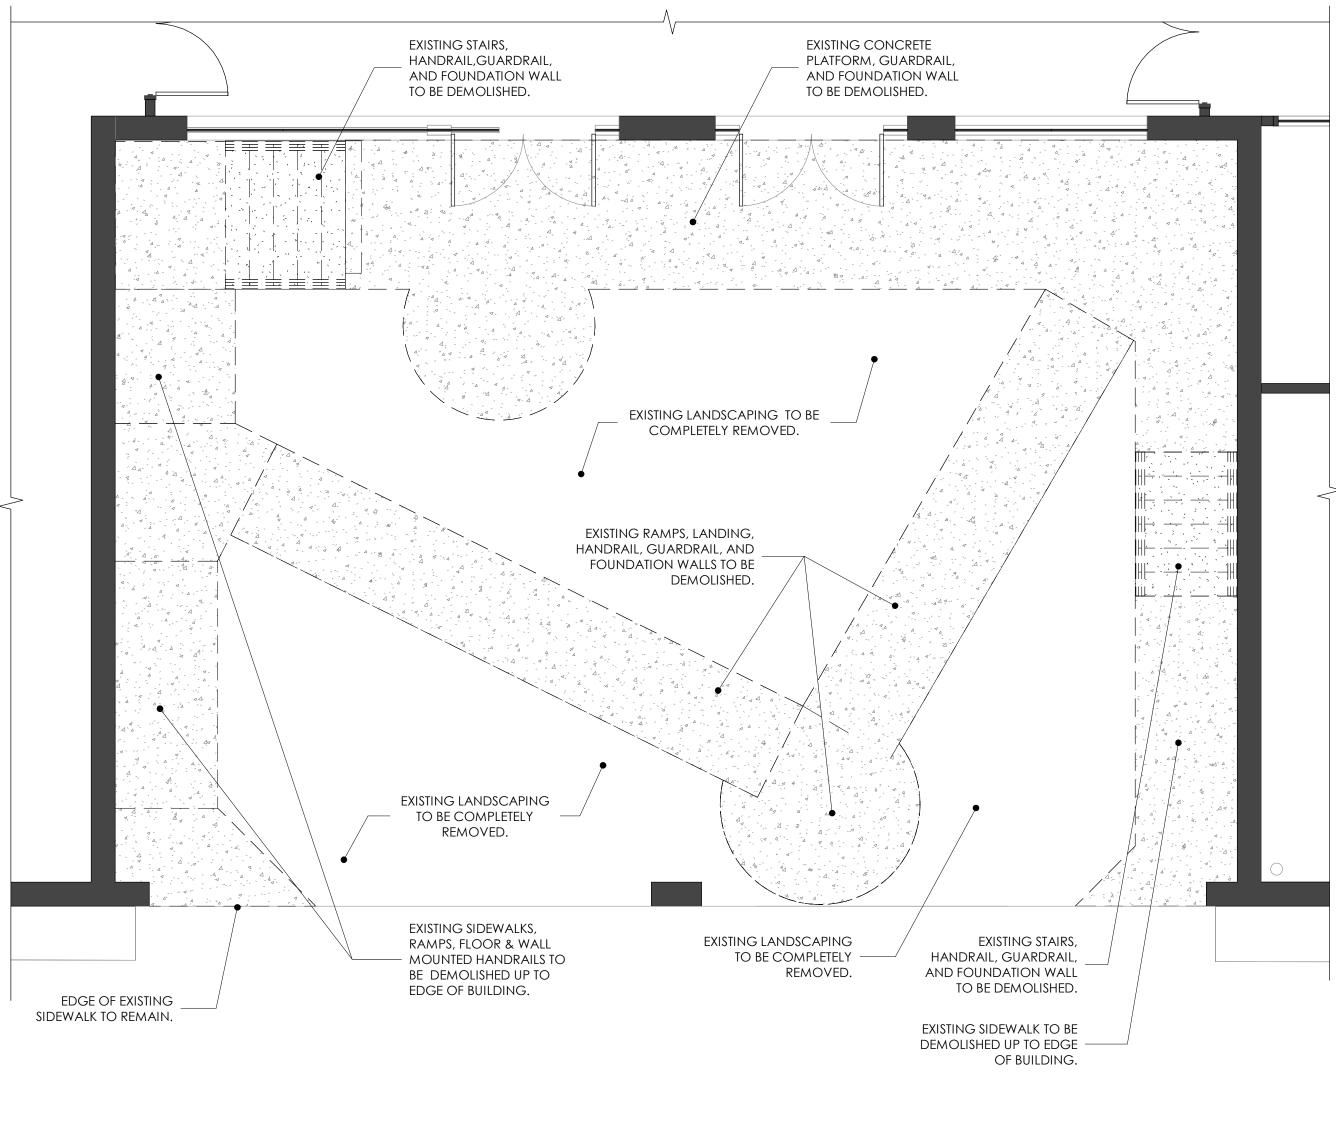







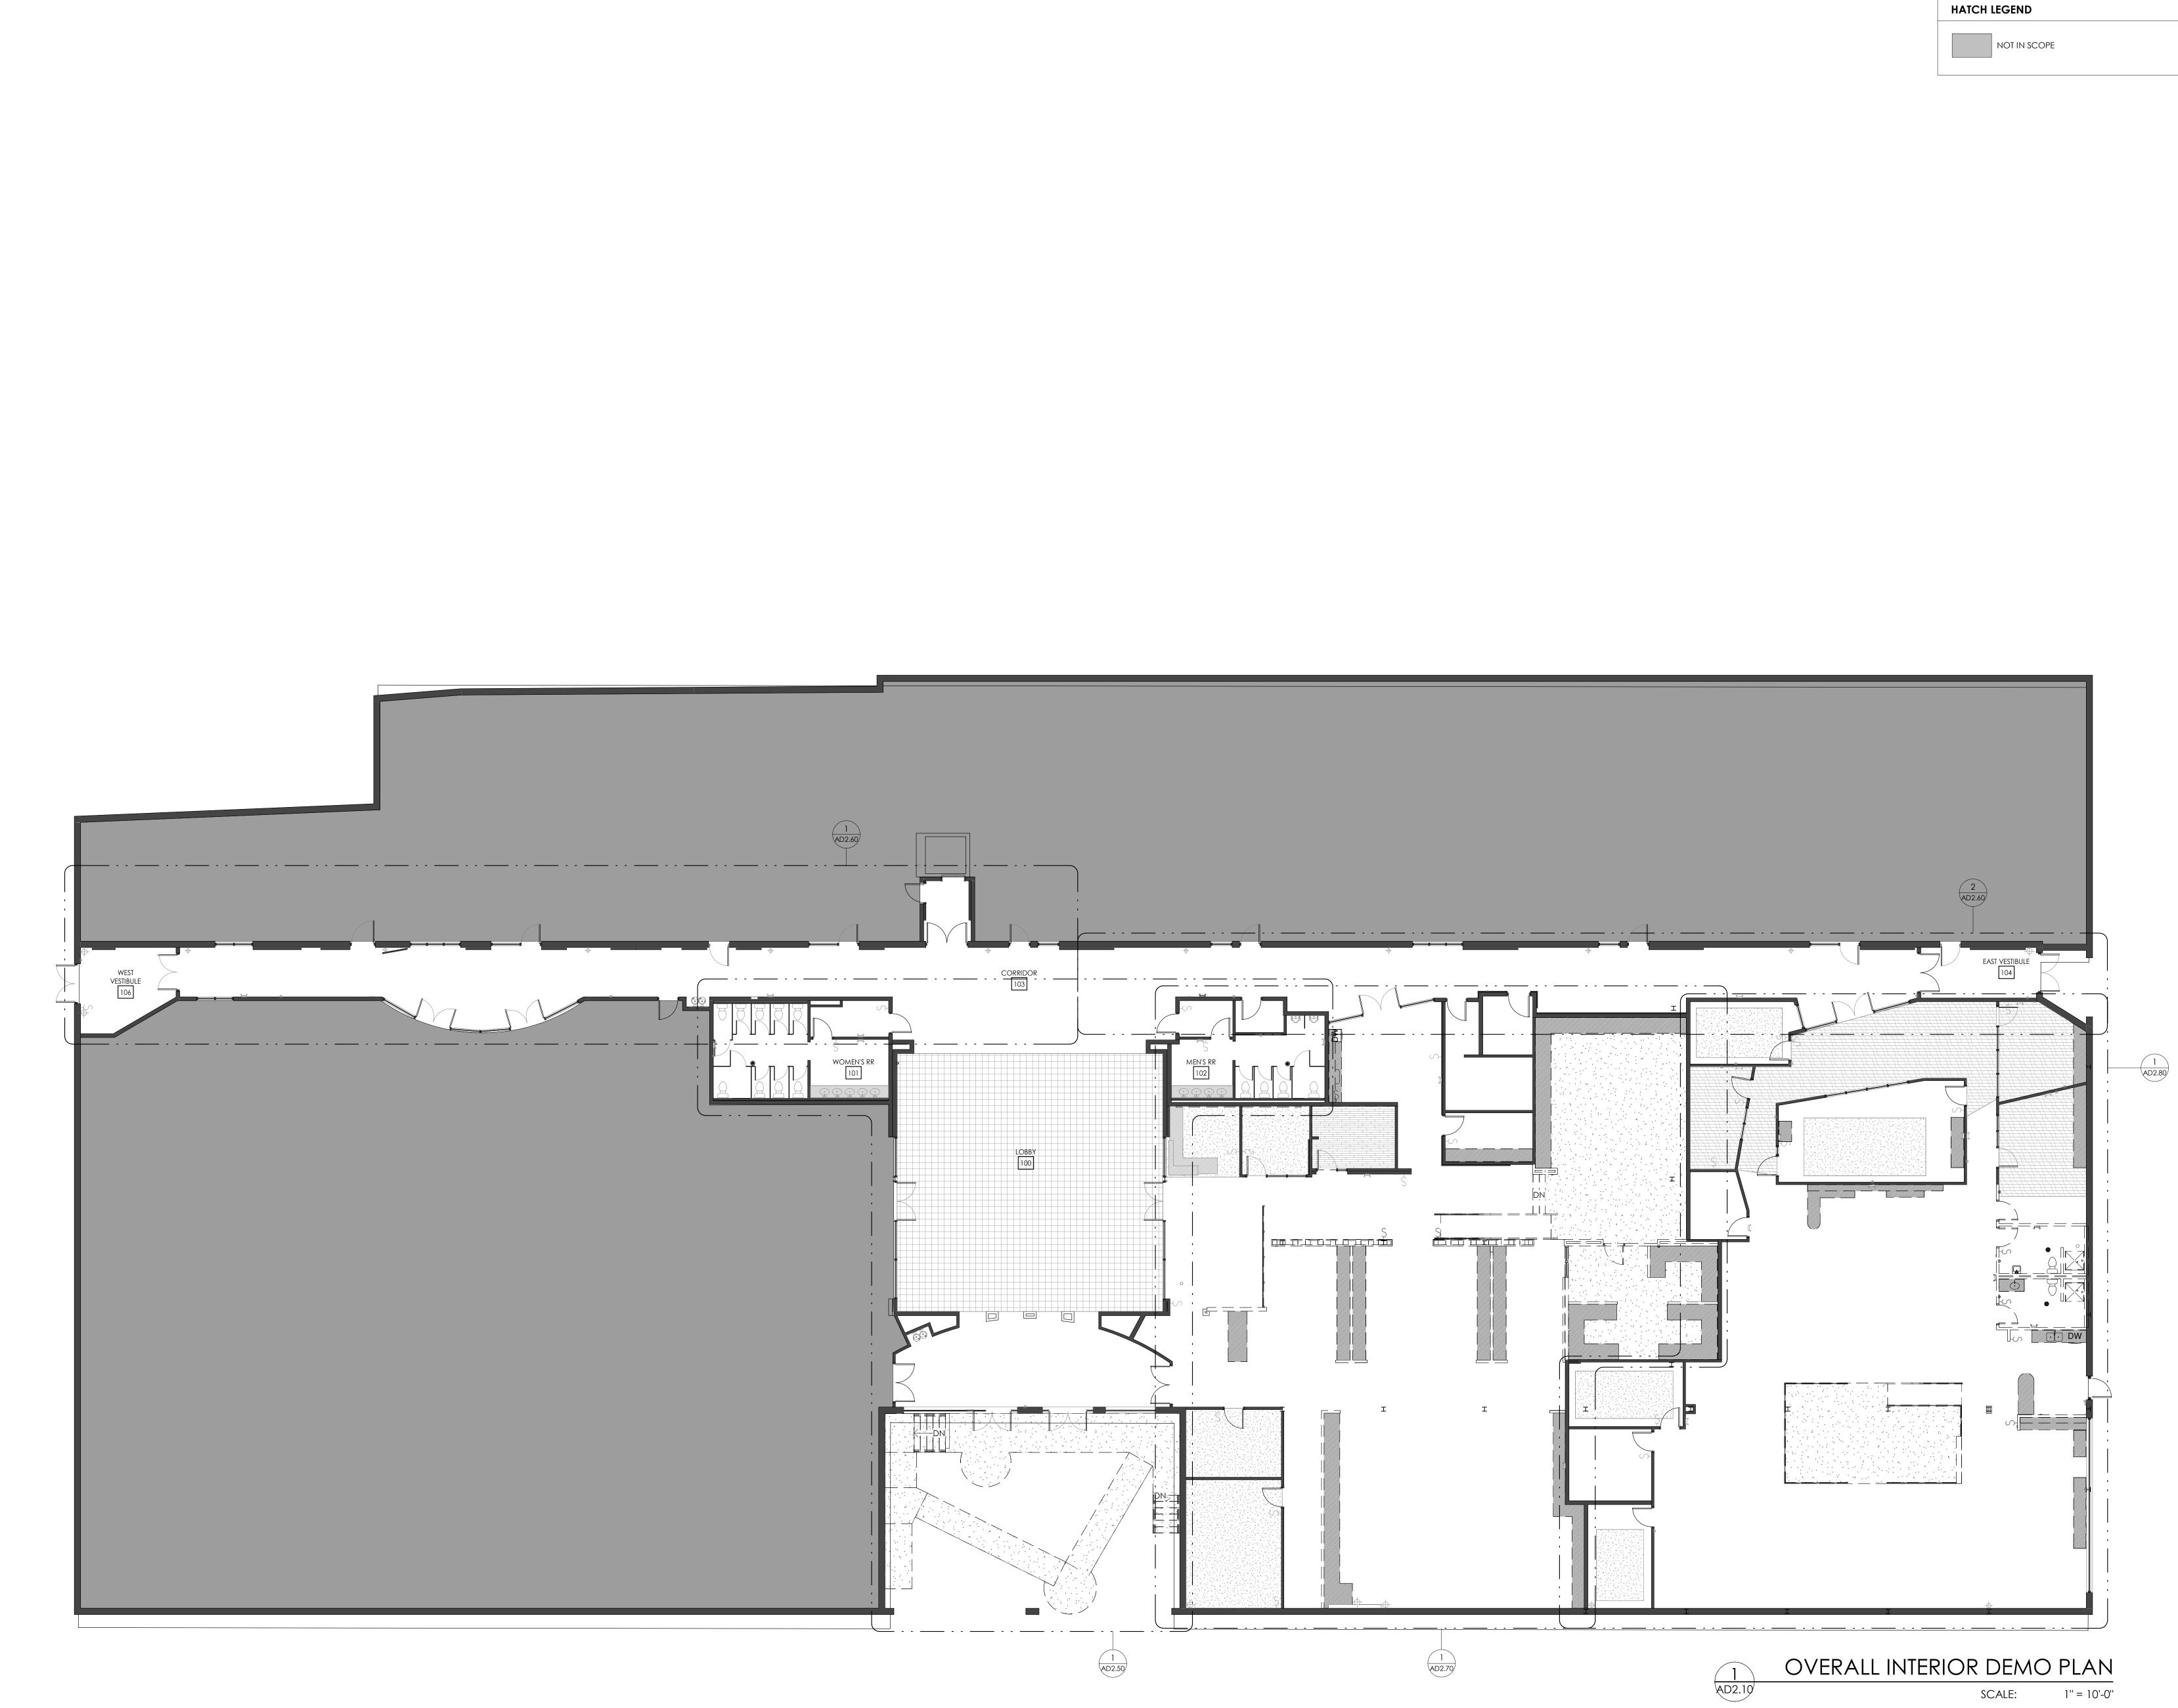
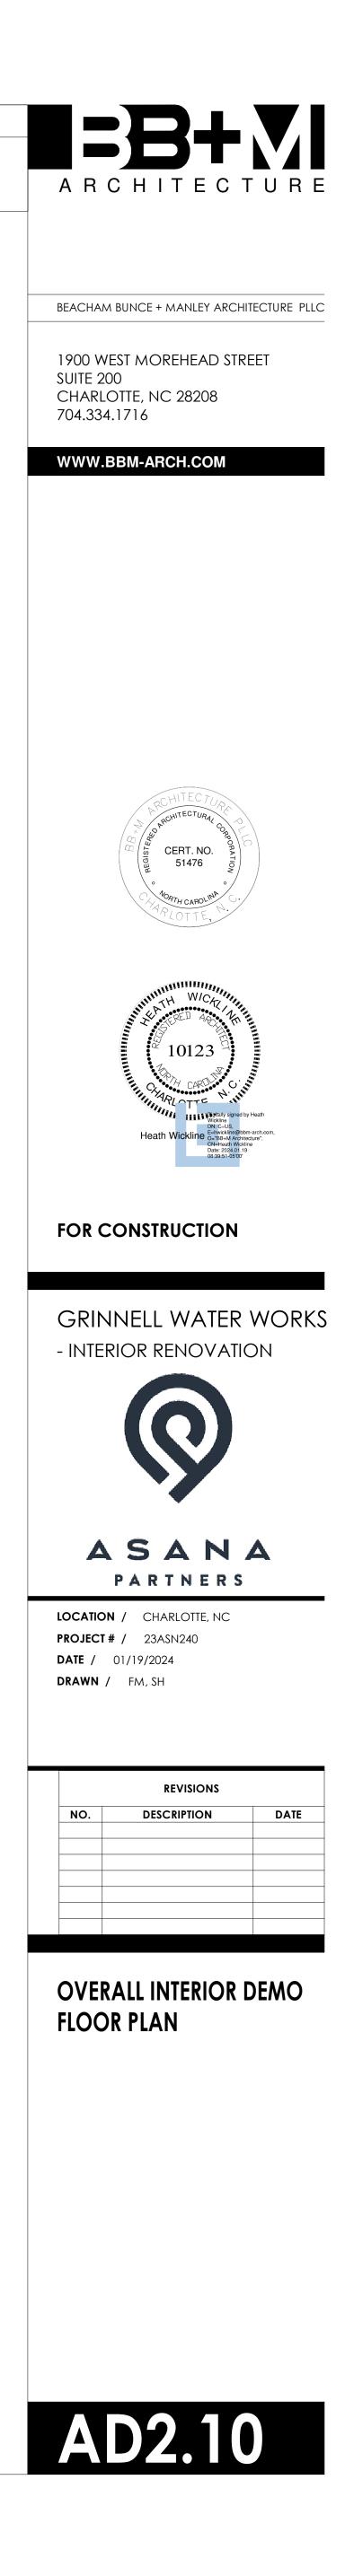
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SYMBOL LEGEND - DEMO





- 1. FIELD VERIFY ALL EXISTING CONDITIONS AND NOTIFY ARCHITECT OF ANY DISCREPANCIES PRIOR TO DEMOLITION.
- PROTECT ALL STRUCTURAL MEMBERS FROM ANY DAMAGE DURING DEMOLITION.
 PATH, REPAIR, AND/OR REPLACE ALL AREAS WHERE

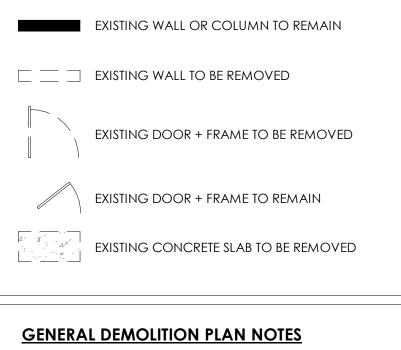
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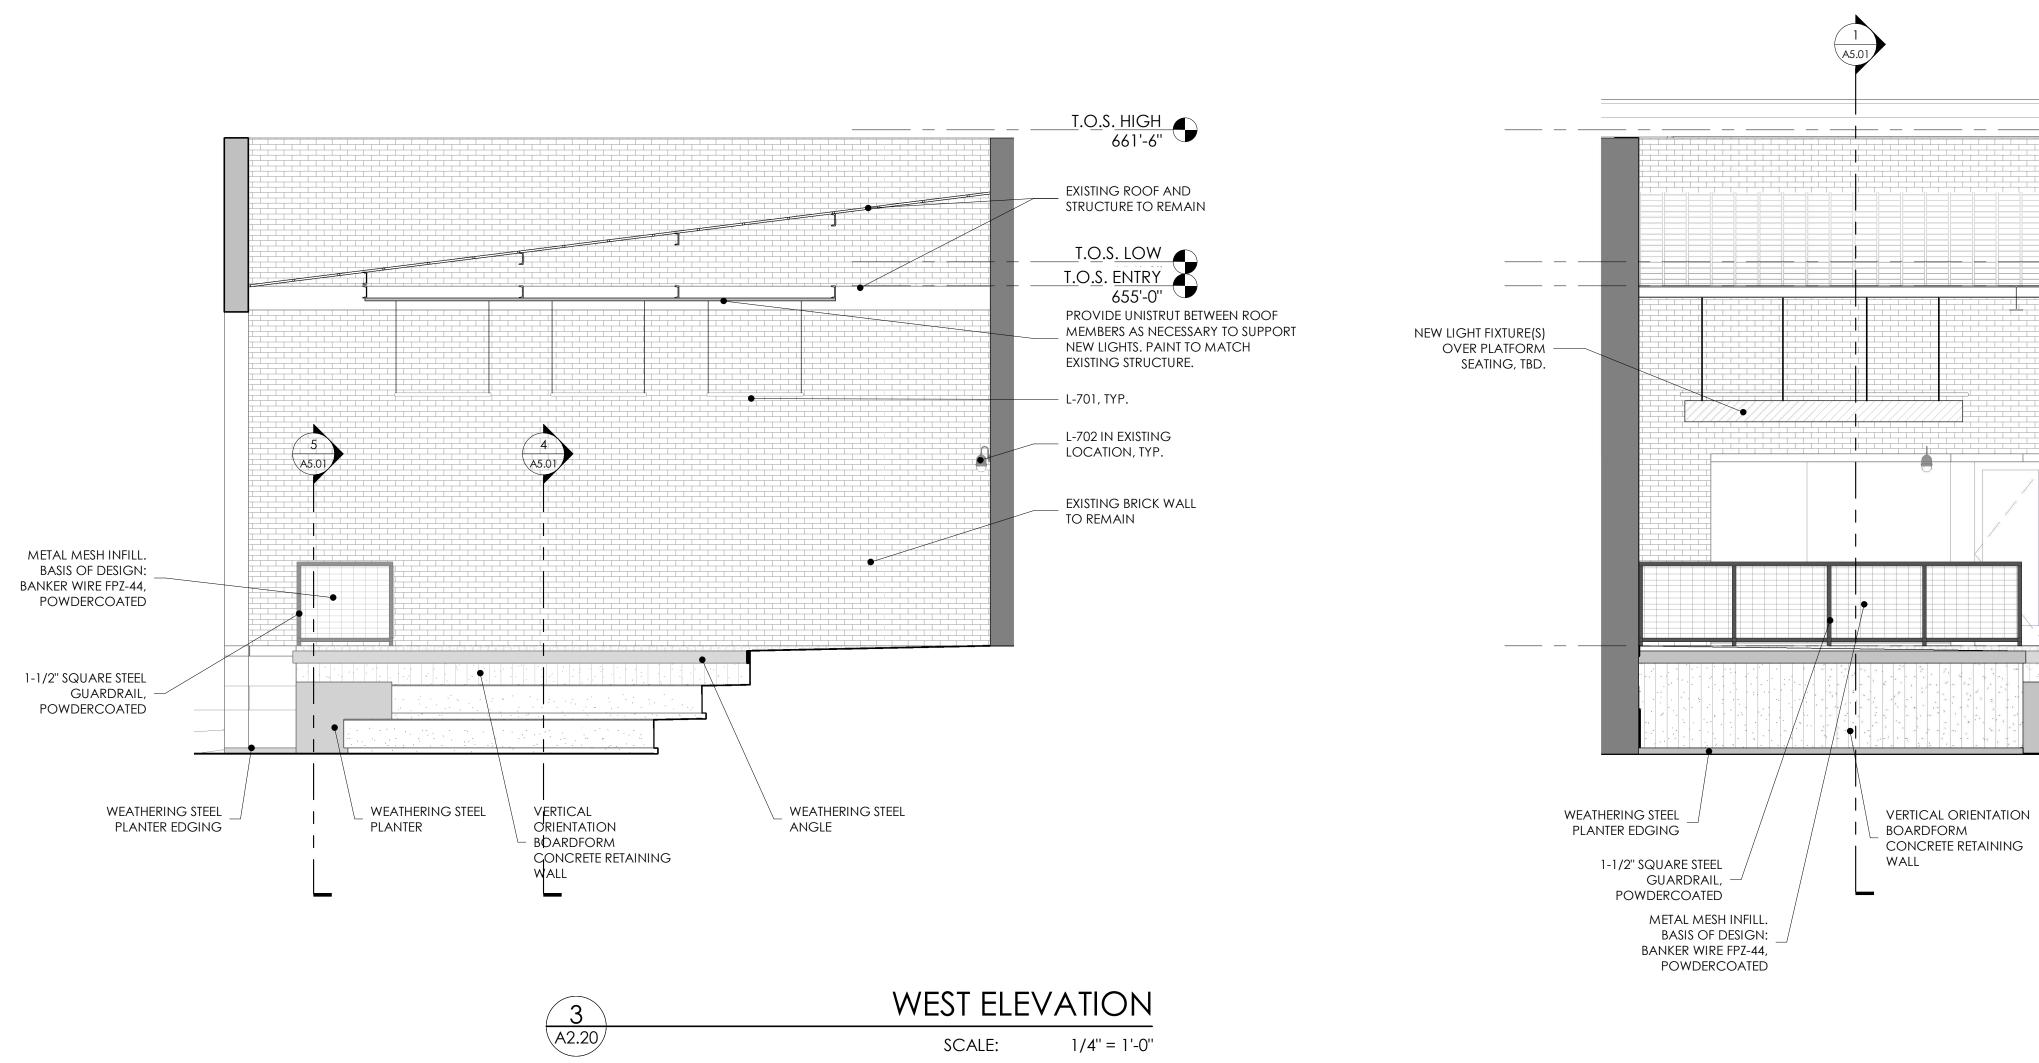
- PATH, REPAIR, AND/OR REPLACE ALL AREAS WHERE DEMOLITION INTERSECTIONS A WALL OR SLAB TO REMAIN.
- 4. ALL DIMENSIONS ARE TO FACE OF BRICK, FACE OF STUD, CENTERLINE OF OPENINGS, CENTERLINE OF COLUMN, AND FACE OF EXISTING TO REMAIN WALLS UNLESS OTHERWISE





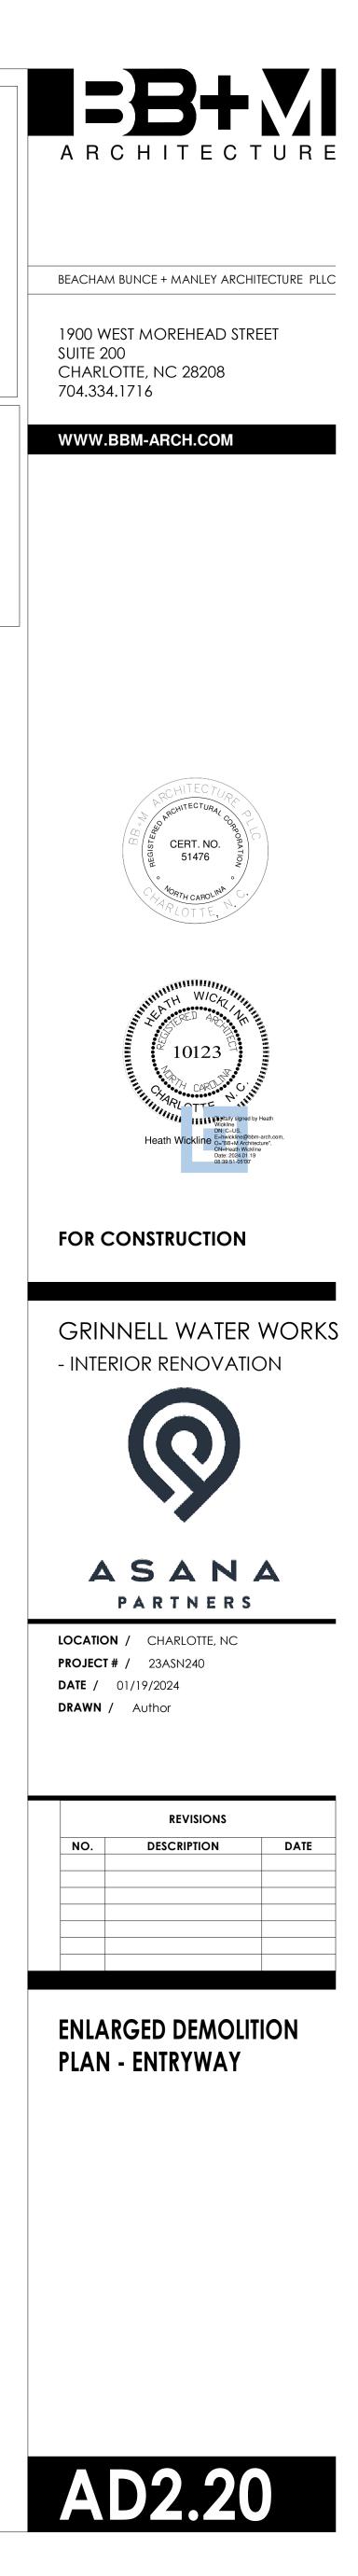


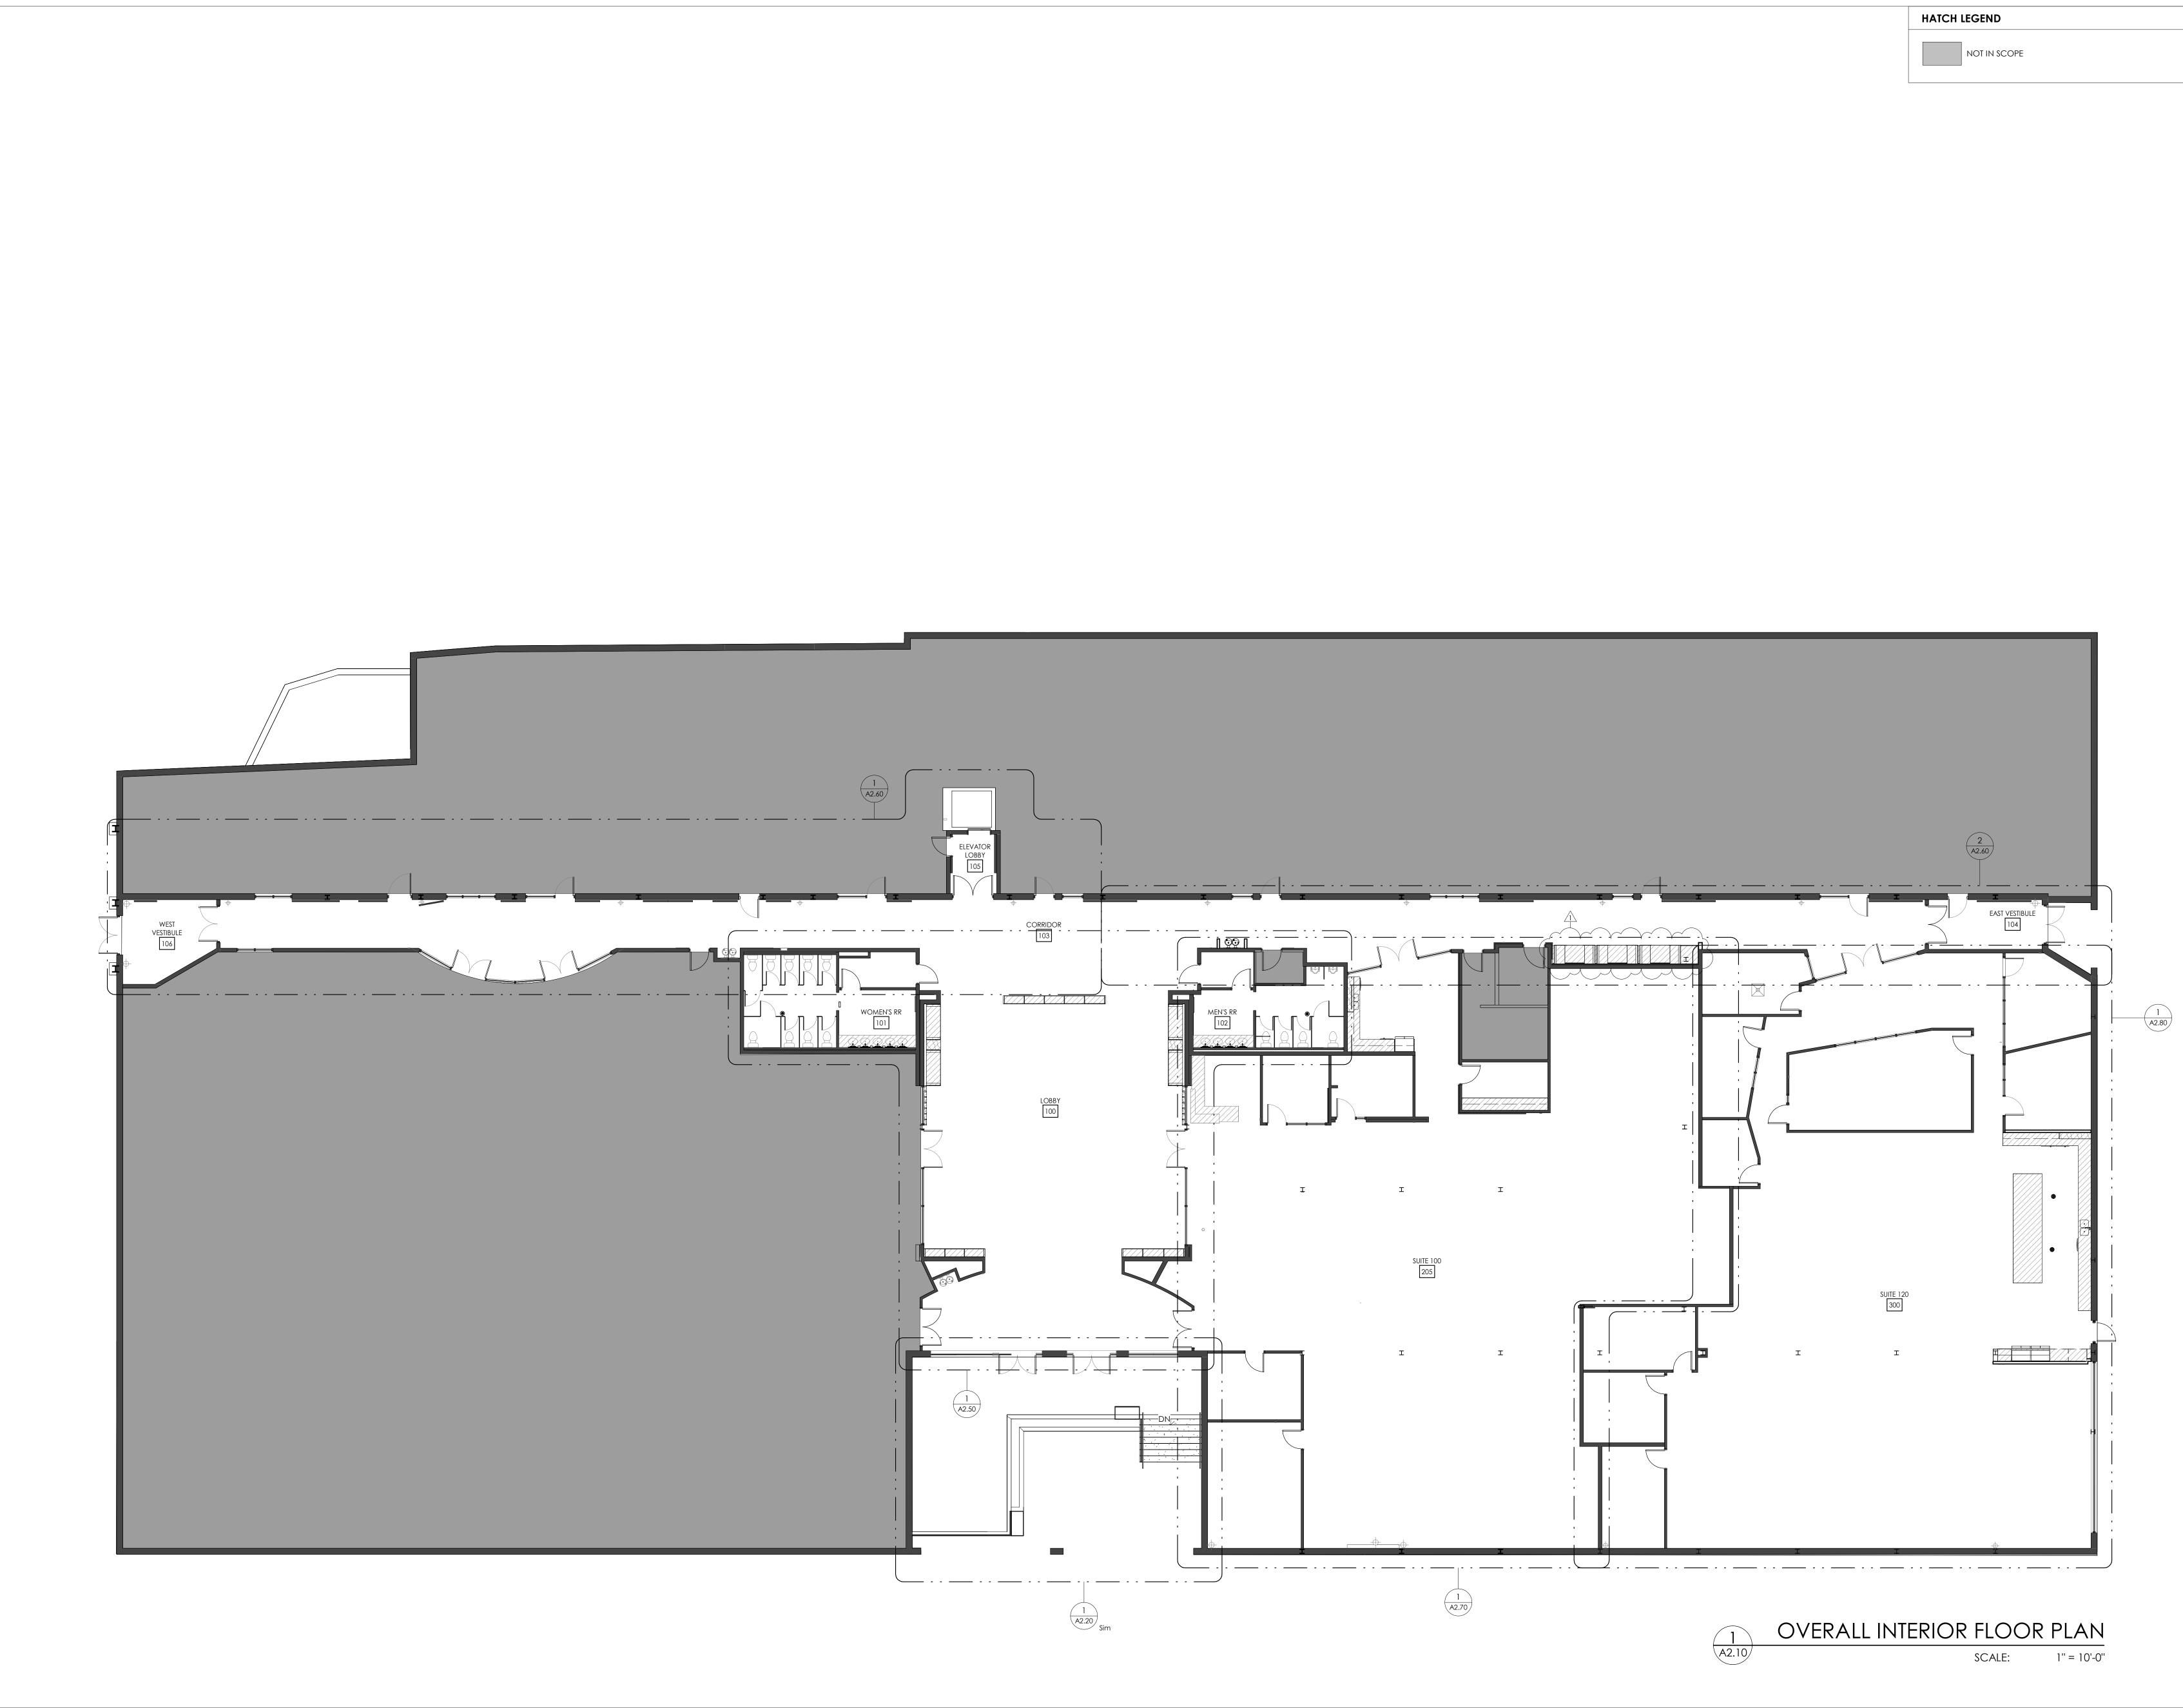

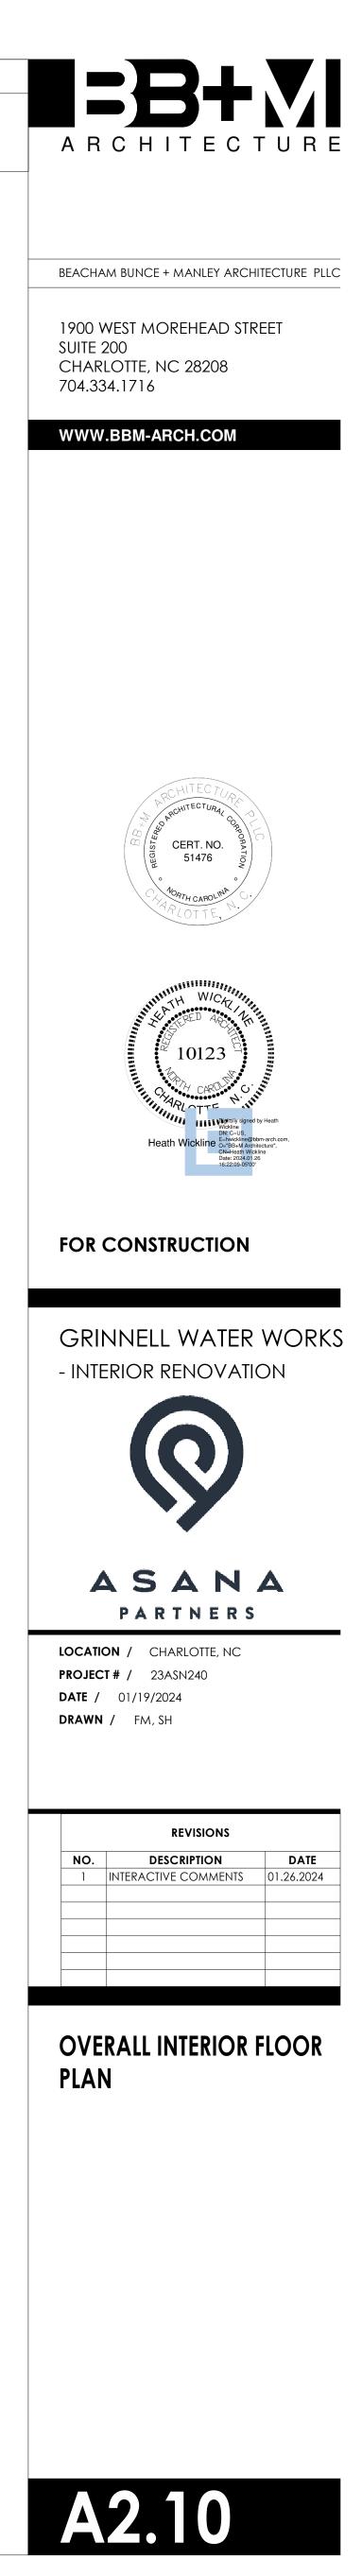


SCALE:


1/4" = 1'-0"

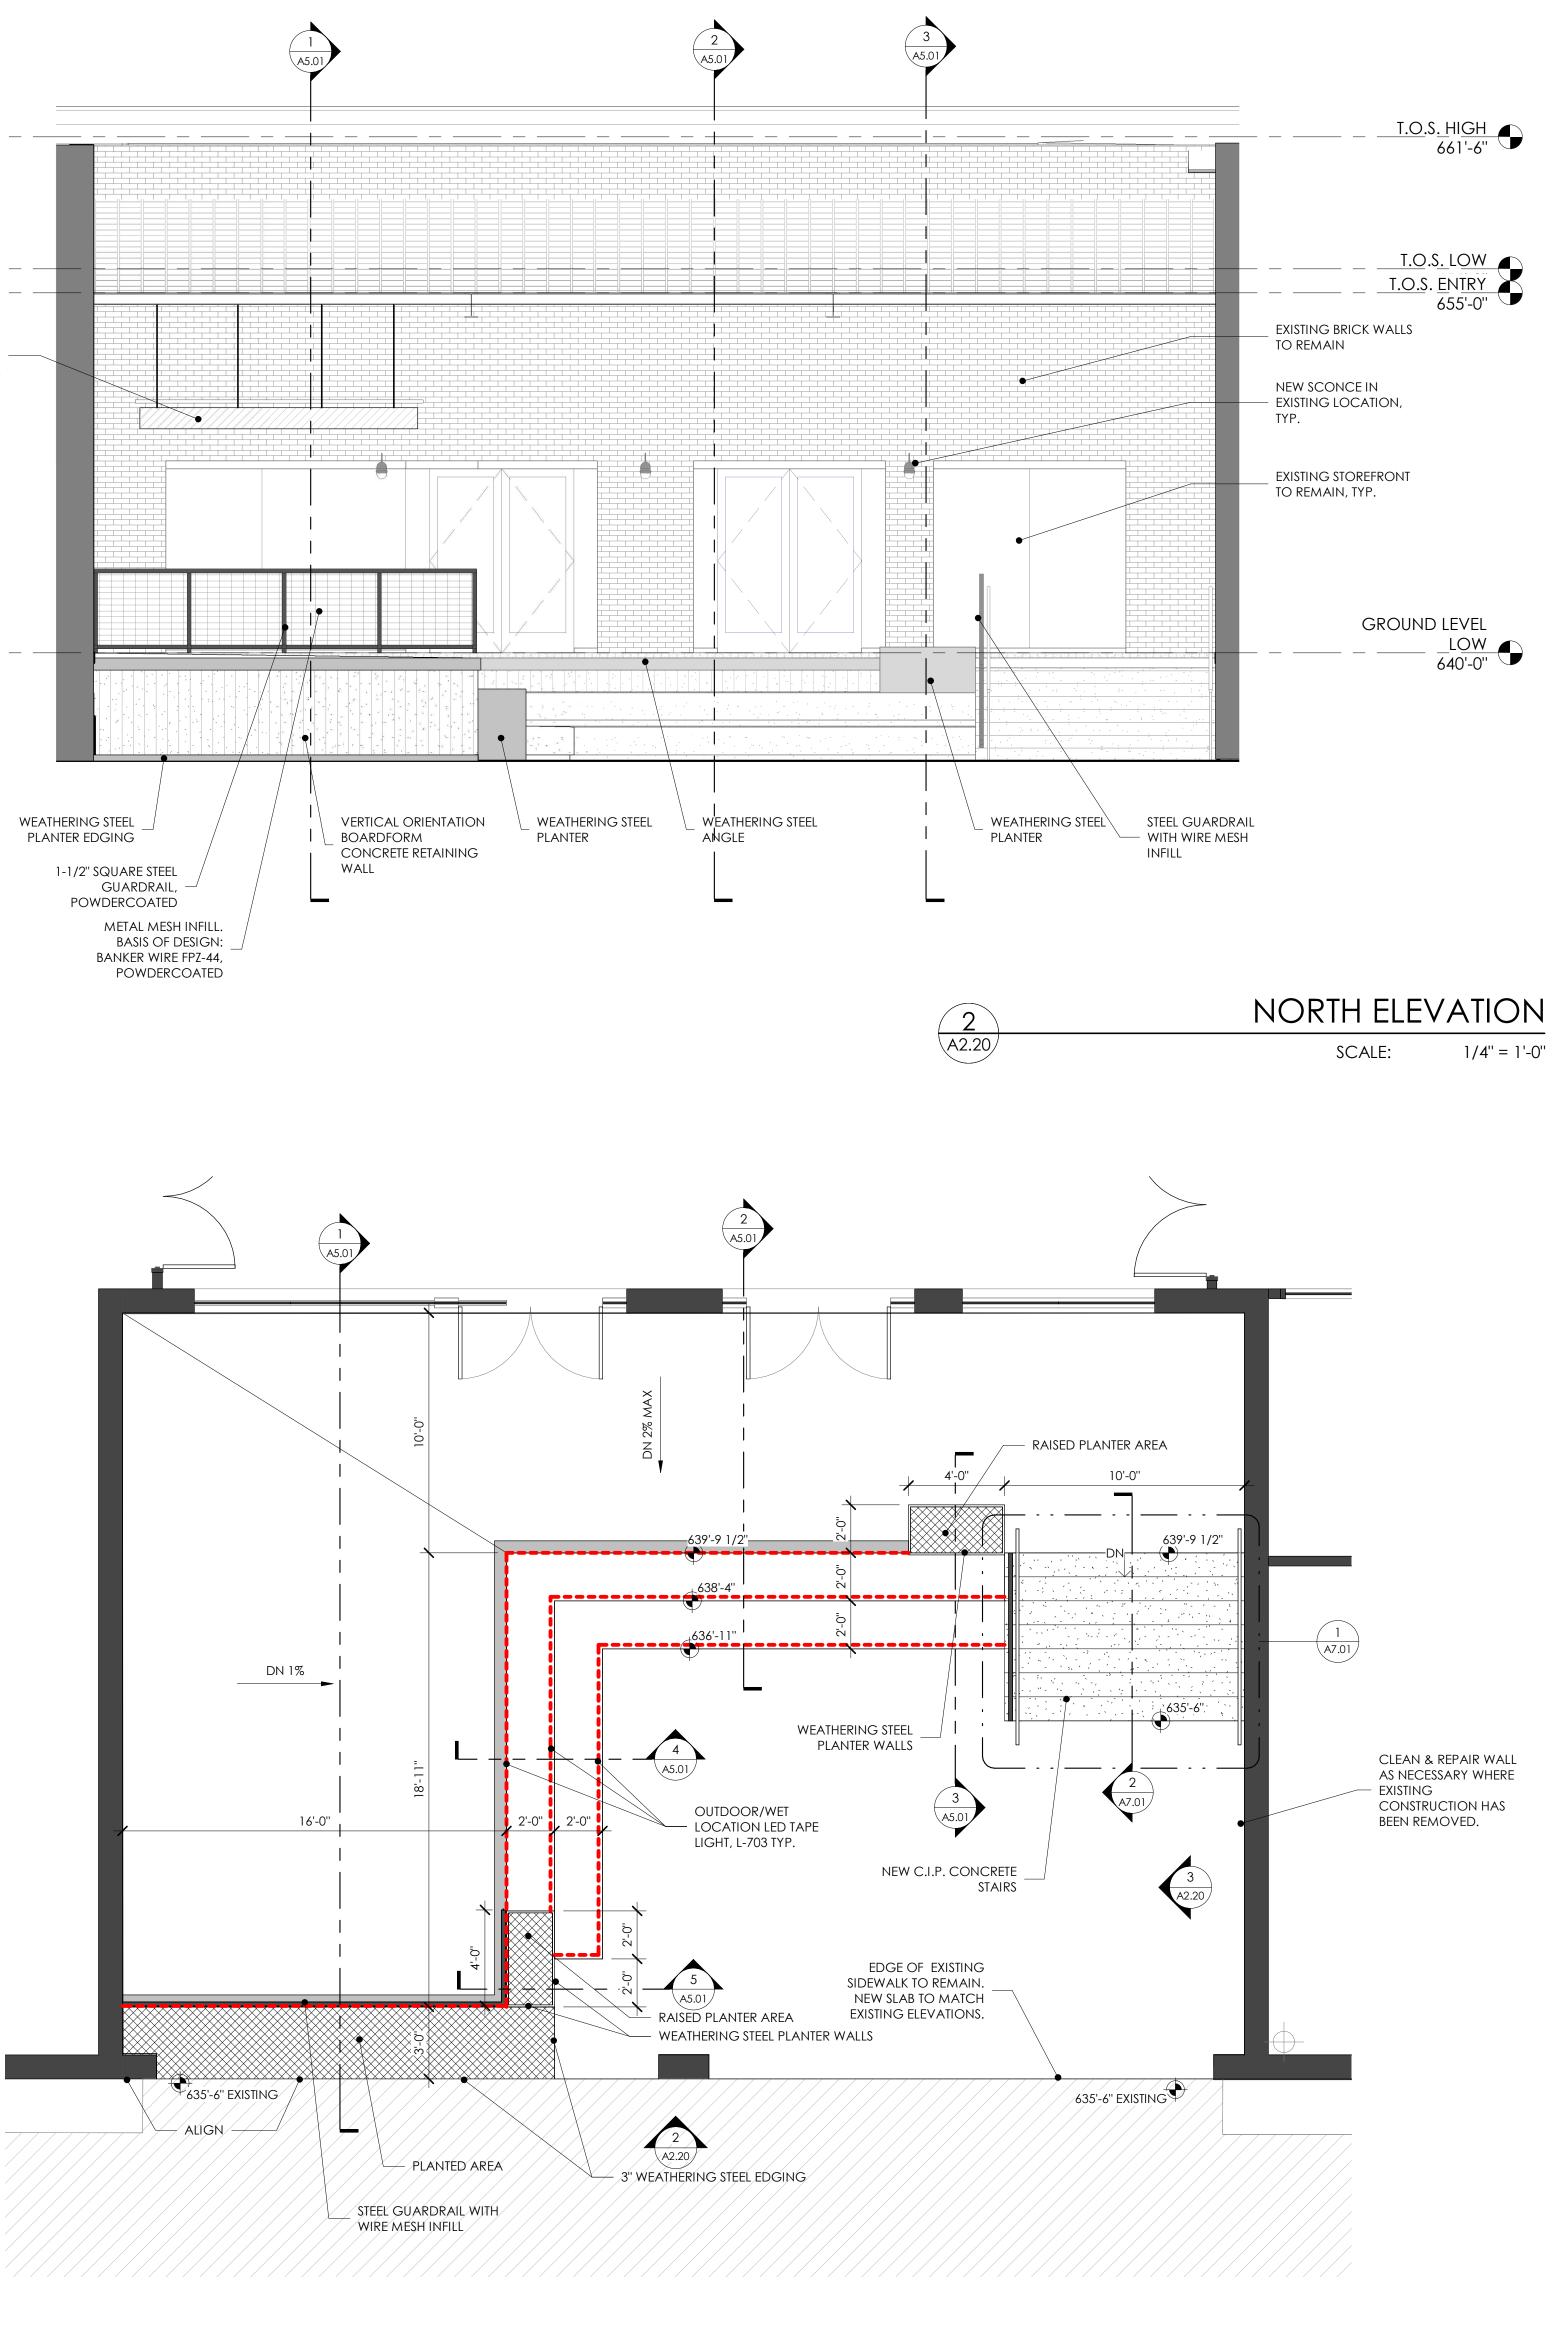

$\overline{1}$	ENLARGED PLAN - EI	NTRYWAY
A2.20	SCALE:	1/4'' = 1'-0''

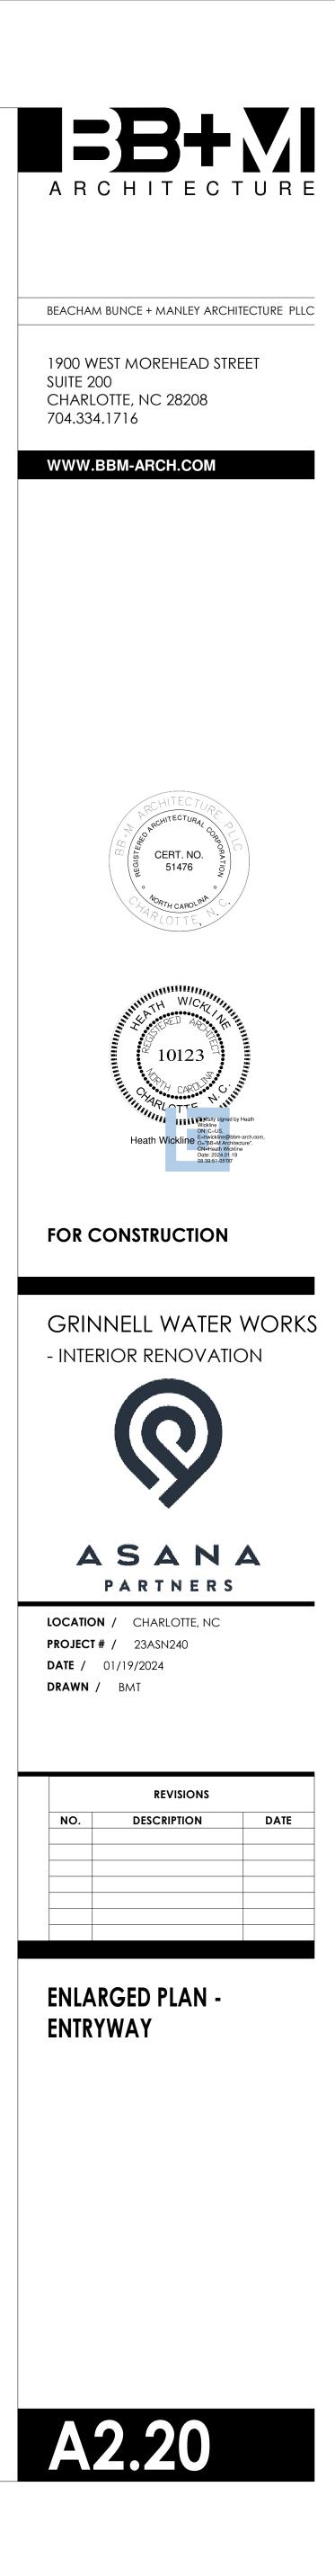

REFER TO ENLARGED PLANS AND FINISH SCHEDULE FOR FURTHER INFORMATION.

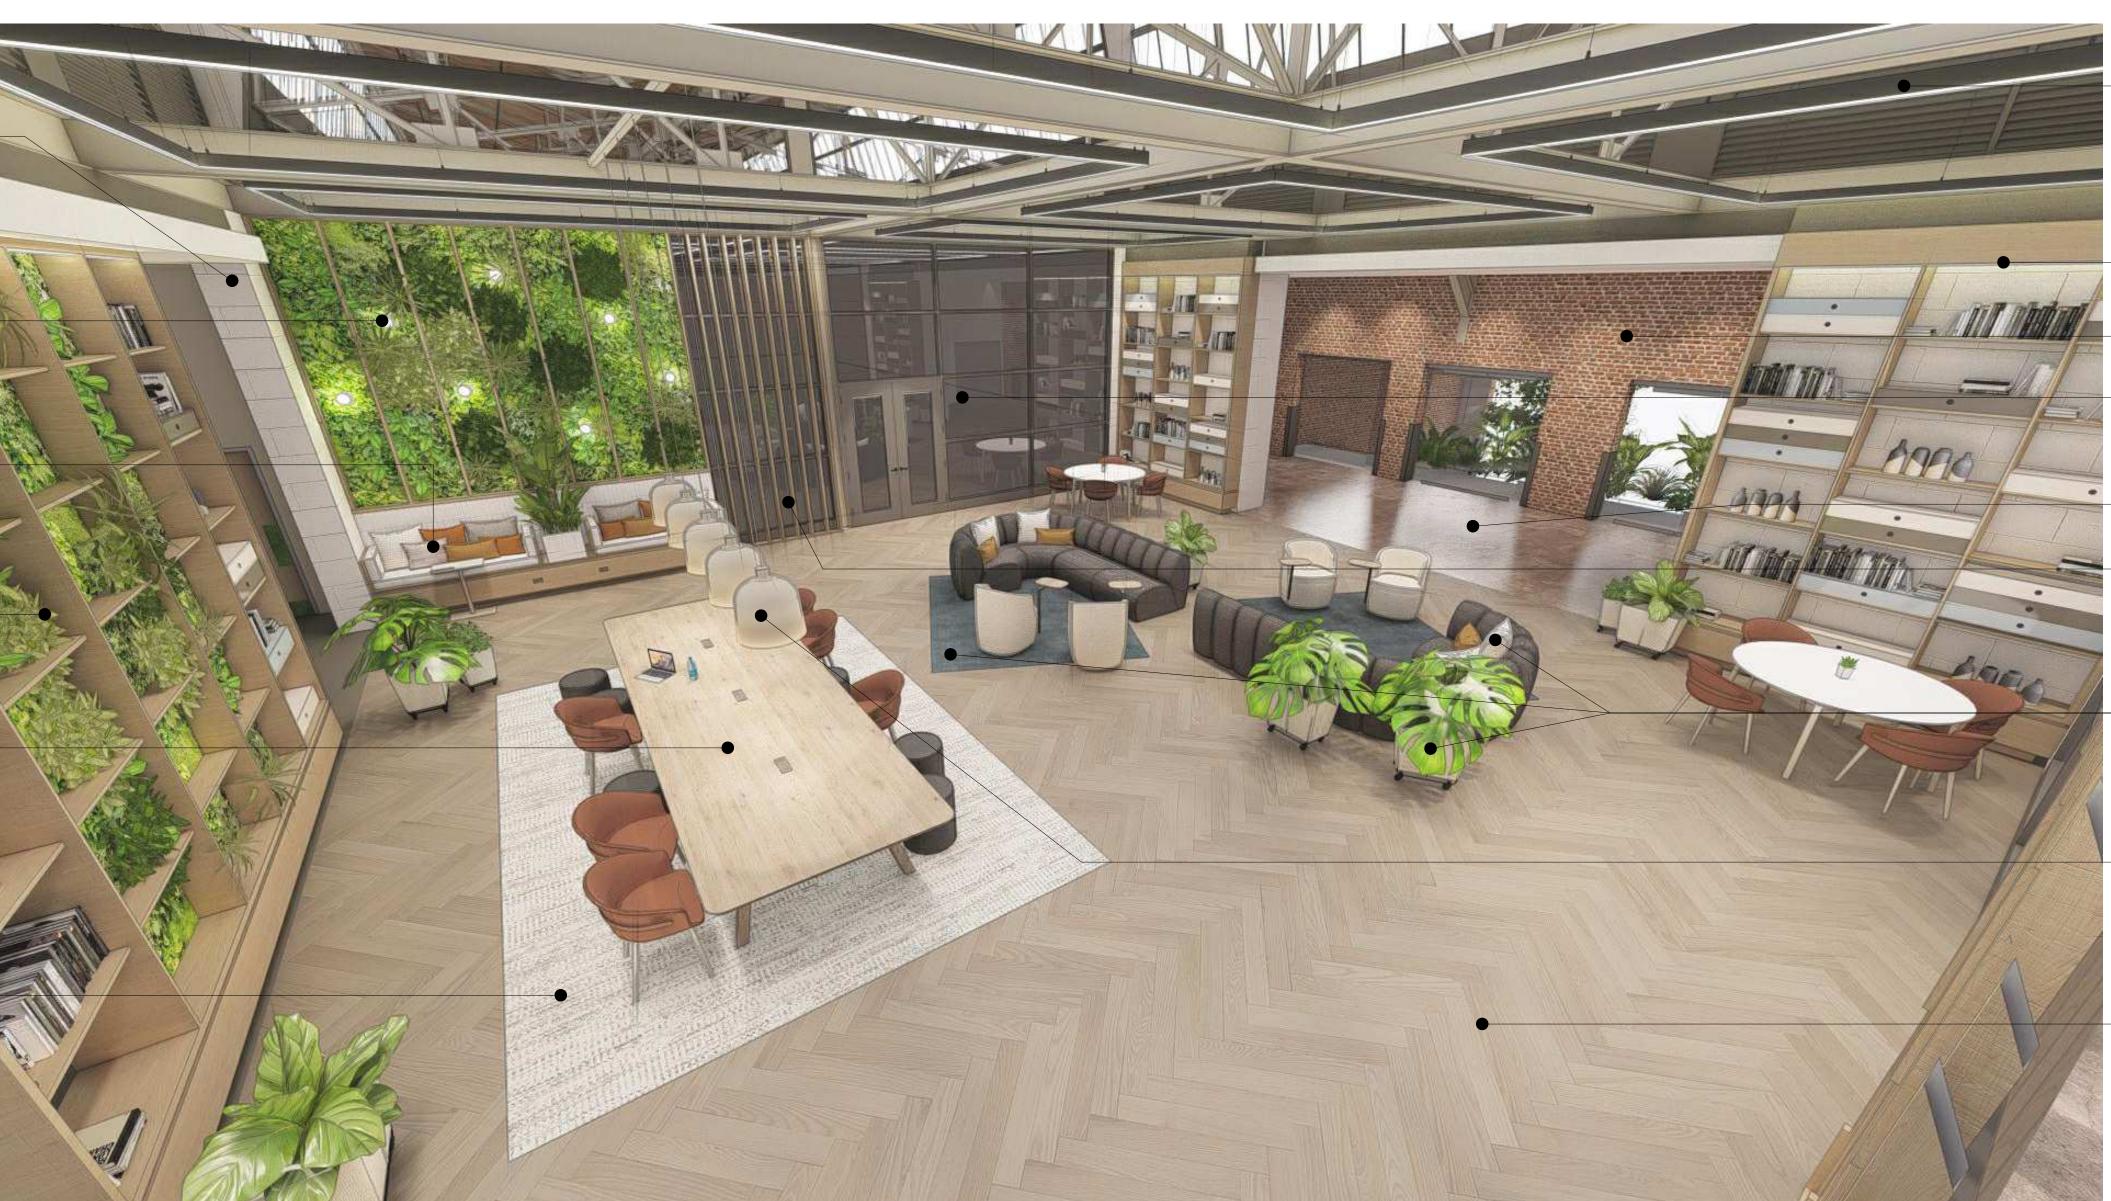

-E IT

PAINTED EXISTING CMU WALLS -

FAUX LIVING WALL PANELS WITHIN STAINED WOOD TRIM SLATS. DECORATIVE WALL SCONCES INCORPORATED INTO WALL DESIGN.

BUILT-IN STAIN-GRADE WOOD BANQUETTE SEATING WITH INCORPORATED POWER AND TILE BACKSPLASH. CUSHIONS AND PLANTER WILL BE PURCHASED BY CLIENT THROUGH FF+E.

> FAUX LIVING WALL PANEL WITHIN STAIN-GRADE WOOD MILLWORK (OPPOSITE SIDE IS SOLID WOOD PANEL)

COMMUNAL LIBRARY TABLE WITH BUILT-IN POWER; POWER SOURCE IS FROM FLOOR OUTLET BELOW. TABLE PURCHASED BY CLIENT THROUGH FF+E. -


CARPET TILE INLAY -

PAINTED EXISTING CMU WALLS -

FAUX LIVING WALL PANELS WITHIN STAINED WOOD TRIM SLATS. DECORATIVE WALL SCONCES INCORPORATED INTO WALL DESIGN.

BUILT-IN STAIN-GRADE WOOD BANQUETTE SEATING WITH INCORPORATED POWER AND TILE BACKSPLASH. CUSHIONS AND PLANTER WILL BE PURCHASED BY CLIENT THROUGH FF+E. -

NOTE: RENDERED VIEWS ARE INCLUDED TO HELP CONVEY DESIGN INTENT AND AID IN PRICING EXERCISES. RENDERINGS DO NOT INDICATE FINAL DESIGN DIRECTION NOR CONVEY ALL REQUIRED CONSTRUCTION DETAILS.

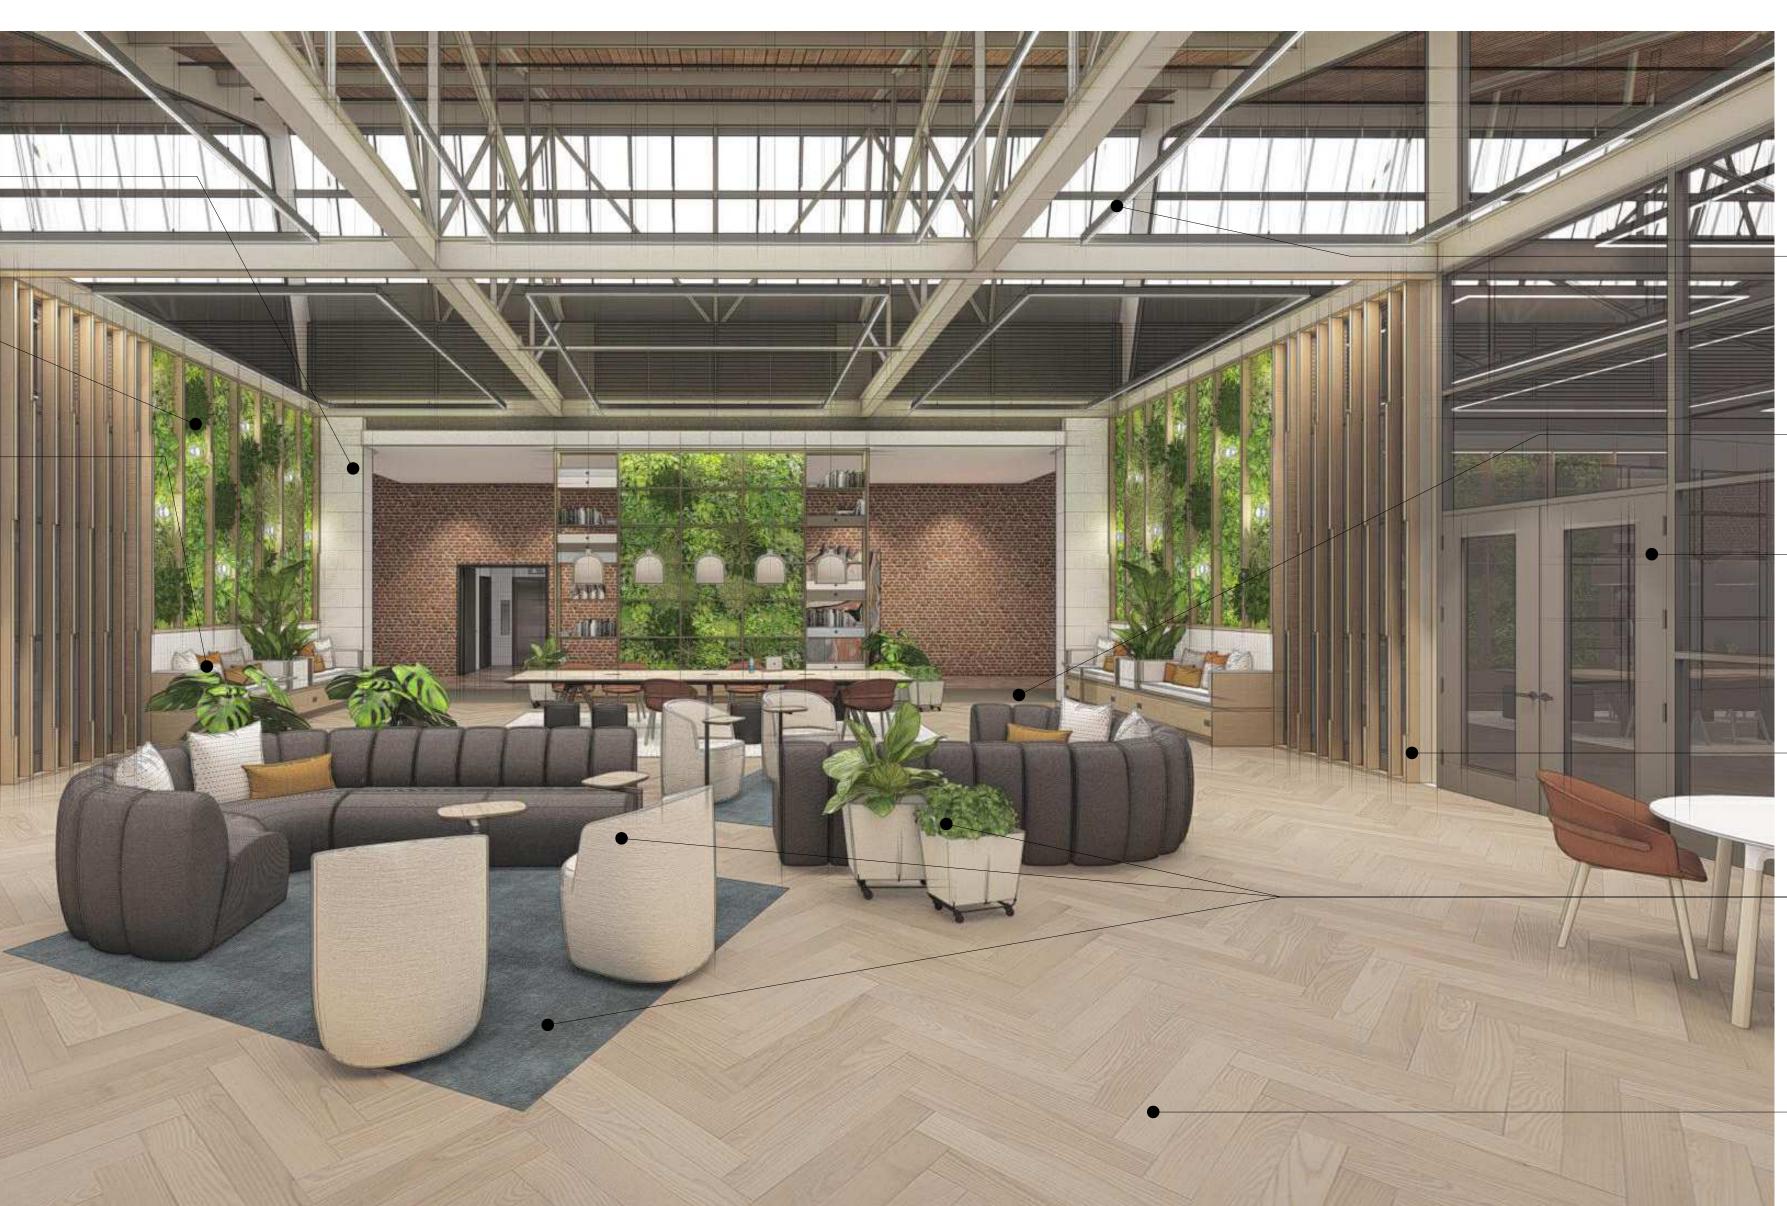

- NEW LINEAR PENDANT LIGHTS THAT SIT WITHIN OPENINGS OF THE EXISTING CEILING STRUCTURE

- STAIN-GRADE WOOD MILLWORK WITH POWER ACCESS AND RECESSED COVELIGHT - EXISTING BRICK WALLS

- PAINTED EXISTING STOREFRONT FRAMES WITH FILM ON GLAZING.

- EXISTING CONCRETE FLOOR

- STAIN-GRADE WOOD SLAT DIVIDER IN FRONT OF STOREFRONT.

- FURNITURE, RUGS AND FLOOR PLANTS TO PURCHASED BY CLIENT THROUGH FF+E.

- NEW PENDANT LIGHTS THAT HANG OVER CONFERENCE TABLE.

WOOD FLOORING IN HERRINGBONE FLOOR INSTALLATION THROUGHOUT LOBBY.

- NEW LINEAR PENDANT LIGHTS THAT SIT WITHIN OPENINGS OF THE EXISTING CEILING STRUCTURE


- EXISTING PAINTED FLOOR WITH NEW PAINT COLOR

- PAINTED EXISTING STOREFRONT FRAMES WITH FILM ON GLAZING.

- STAIN-GRADE WOOD SLAT DIVIDER IN FRONT OF STOREFRONT.

- FURNITURE, RUGS AND FLOOR PLANTS TO PURCHASED BY CLIENT THROUGH FF+E.

WOOD FLOORING IN HERRINGBONE FLOOR INSTALLATION THROUGHOUT LOBBY.

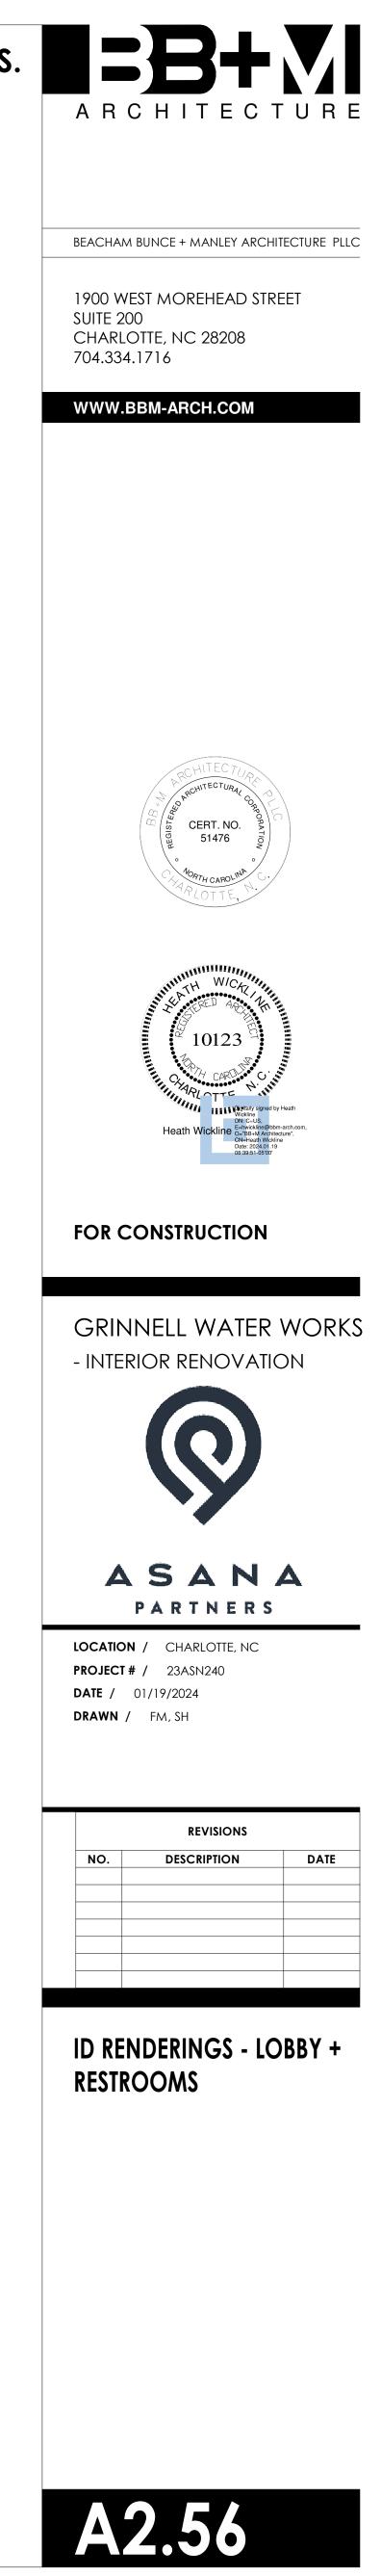

NOTE: RENDERED VIEWS ARE INCLUDED TO HELP CONVEY DESIGN INTENT AND AID IN PRICING EXERCISES. RENDERINGS DO NOT INDICATE FINAL DESIGN DIRECTION NOR CONVEY ALL REQUIRED CONSTRUCTION DETAILS. REFER TO ENLARGED PLANS AND FINISH SCHEDULE FOR FURTHER INFORMATION.







BUILT-IN WOOD-LOOK PLASTIC LAMINATE FLOATING DISPLAY SHELVES

SUBWAY TILE BACKSPLASH

BLACK CABINET PULLS

QUARTZ COUNTERTOPS

BUILT-IN WOOD-LOOK PLASTIC LAMINATE CASEWORK CABINETS

EXISTING STAINED CONCRETE FLOORS

OPEN OFFICE WORK STATIONS AND FURNITURE PURCHASED BY FUTURE TENANT.

BUILT-IN WOOD-LOOK PLASTIC LAMINATE FLOATING DISPLAY SHELVES

SUBWAY TILE BACKSPLASH

- BLACK CABINET PULLS
- BUILT-IN NEW EQUIPMENT -
- QUARTZ COUNTERTOPS

BUILT-IN WOOD-LOOK PLASTIC LAMINATE CASEWORK CABINETS

EXISTING STAINED CONCRETE FLOORS

- NEW PENDANT LIGHTS THROUGHOUT SUITE.

- NEW PENDANT LIGHTS OVER ISLAND, ALONG WITH LARGE LINEAR PENDANT OVER CAFE

- NEW AND BUILT-IN APPLIANCES IN CAFE

BUILT-IN ISLAND WITH TILE BACKSPLASH AND QUARTZ WATERFALL EDGE

- CARPET TILE WITH RUBBER TRANSITIONS AT edges

- NEW LARGE LINEAR PENDANT OVER CAFE

- NEW PENDANT LIGHTS OVER ISLAND

- NEW KITCHEN SINK AND MATTE BLACK FAUCET

- NEW AND BUILT-IN APPLIANCES IN CAFE

BUILT-IN ISLAND WITH TILE BACKSPLASH AND QUARTZ WATERFALL EDGE

